



October 23, 2023

TNHC OREGON LLC ATTN: CHRIS WALTHER 15455 GREENBRIER PARKWAY, SUITE 240 BEAVERTON OR 97006

# Re: Vineyard at Cooper Mountain; Phase 2 Design Review; CWS file 18-002050 (Tax map 1S13100 Tax lots 01600 & 01605)

Clean Water Services has reviewed the Service Provider Letter issued on August 16, 2018 and the Amended SPL issued on May 20, 2019 for file 18-002050. District staff has evaluated the Service Provider Letter conditions and project plans for Phase 2 and found them to be in compliance with Resolution and Order 19-5 (R&O 19-5), as amended by Resolution and Order 19-22 (R&O 19-22). Please attach this letter to the existing Amended Service Provider Letter for all applications made after November 2019, to demonstrate compliance with R&O 19-5, as amended by R&O 19-22.

Sincerely,

Stacy Benjamin

Stacy Benjamin Environmental Plan Review

Attachments (2)

# THE VINEYARD AT COOPER MOUNTAIN - PHASE 2 - TOWNHOMES

#### APPLICANT

STANTON STREET BUILDING COMPANY, LLC PO BOX 1297 CANNON BEACH, OR 97110 PHONE (503) 313-7795 CONTACT: PAM VERDADERO EMAIL: PAMV@STANTON-STREET.COM

#### OWNER

AG EHC II (NWHM) MULTI STATE 2 LLC 15231 LAGUNA CANYON ROAD, SUITE 250 IRVINE, CA 92618 PHONE (949) 382-7807 CONTACT: MARK KAWANAMI EMAIL: MKAWANAMI@NWHM.COM

#### PLANNING/ENGINEERING/SURVEYING

PIONEER DESIGN GROUP, INC 9020 SW WASHINGTON SQ RD., SUITE 170 PORTLAND, OR 97223 PHONE (503) 643-8286 CONTACT: MATT SPRAGUE/WAYNE HAYSON LANDSCAPE ARCHITECT

PIONEER DESIGN GROUP, INC. 9020 SW WASHINGTON SQ RD., SUITE 170 PORTLAND, OR 97223 PHONE (503) 643-8286 CONTACT: BEN HOLMES

## SURVEY

PIONEER DESIGN GROUP, INC. 9020 SW WASHINGTON SQ RD., SUITE 170 PORTLAND OR 97223 PHONE (503) 643-8286 CONTACT: MIKE HARRIS, PLS

#### TRAFFIC ENGINEER

KITTELSON & ASSOCIATES, INC. 610 SW AI DER ST., SUITE 700 PORTLAND, OR 97205 PHONE (503) 228-5230 CONTACT: MATT BELL

## ARBORIST

MORGAN HOLEN & ASSOCIATES, LLC 3 MONROE PARKWAY, SUITE P220 LAKE OSWEGO OR 97035 PHONE (971) 409-9354 CONTACT: MORGAN HOLEN

#### GEOTECHNICAL ENGINEER

HARDMAN GEOTECHNICAL SERVICES, INC. (HGSI) 10110 SW NIMBUS AVE. SUITE B-5 TIGARD, OR 97223 PHONE (503) 575-5634 CONTACT: SCOTT HARDMAN, PE, GE EMAIL: SHARDMAN.HGSI@FRONTIER.COM

#### BIOLOGIST

ENVIRONMENTAL SCIENCE & ASSESSMENT, LLC 107 SE WASHINGTON ST., SUITE 249 PORTLAND, OR 97202 PHONE (503) 478-0424 CONTACT: JACK DALTON EMAIL: JACK@ESAPDX.COM

# LIGHTING ENGINEER

R&W ENGINEERING, INC. 9615 SW ALLEN BLVD, SUITE 107 BEAVERTON, OR 97005 PHONE (503) 726-3317 CONTACT: DENNIS HALL EMAIL: DHALL@RWENG.COM

#### VERTICAL DATUM

WASHINGTON COUNTY BENCHMARK NO. 107 LOCATED ON THE SOUTH SIDE OF S.W. SCHOLLS FERRY ROAD NEAR PROJECTED CENTERLINE OF S.W. 175TH AVENUE


# ELEVATION: 306.55


LOCATION


MAP 1S1 31, TAX LOTS 1600 & 1605 17520 SW HORSE TALE DR. BEAVERTON, OR 97007



THIS DESIGN COMPLIES WITH ORS 92.044 (7) IN THAT NO UTILITY INFRASTRUCTURE IS DESIGNED TO BE WITHIN ONE (1) FOOT OF A SURVEY MONUMENT LOCATION SHOWN ON A SUBDIVISION OR PARTINO PLAT. NO DESIGN EXCEPTIONS NOR FINAL FIELD LOCATION CHANGES SHALL BE PERMITTED IF THAT CHANGE WOULD CAUSE ANY UTILITY INFRASTRUCTURE TO BE PLACED WITHIN THE PROHIBITED AREA.

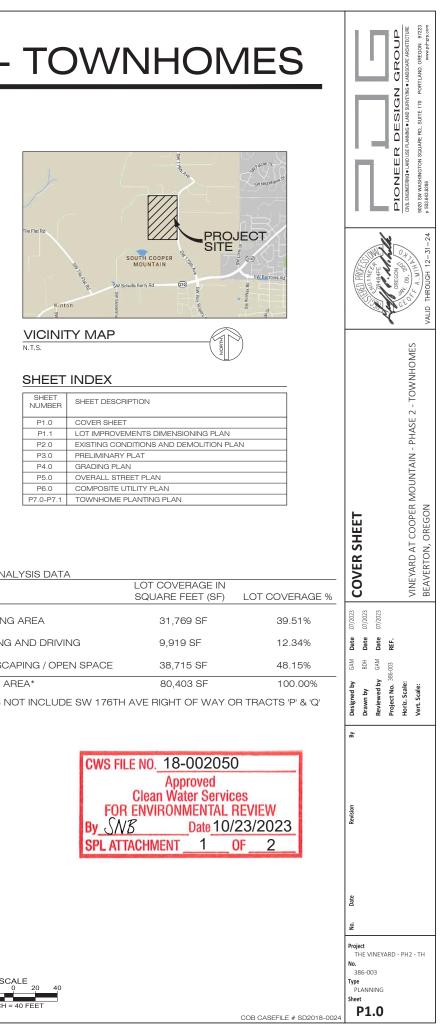

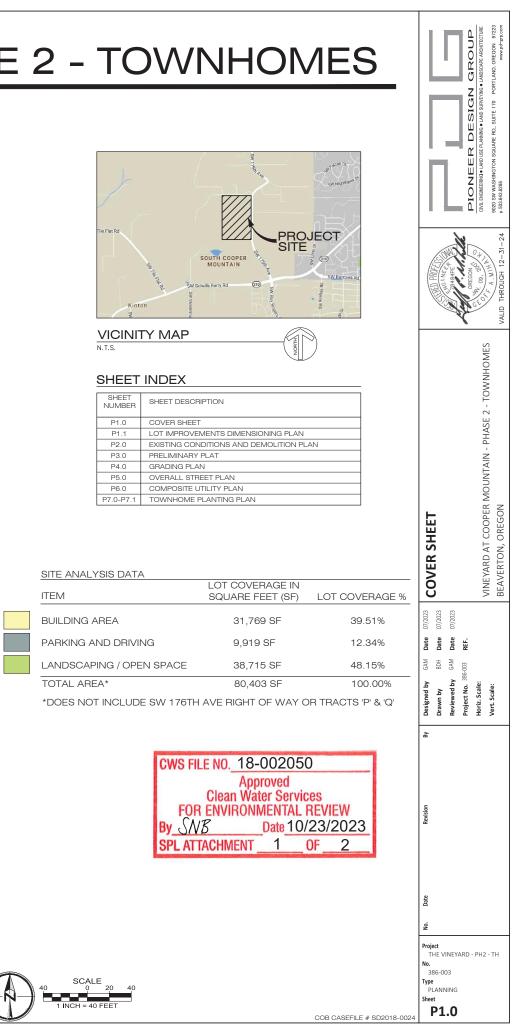

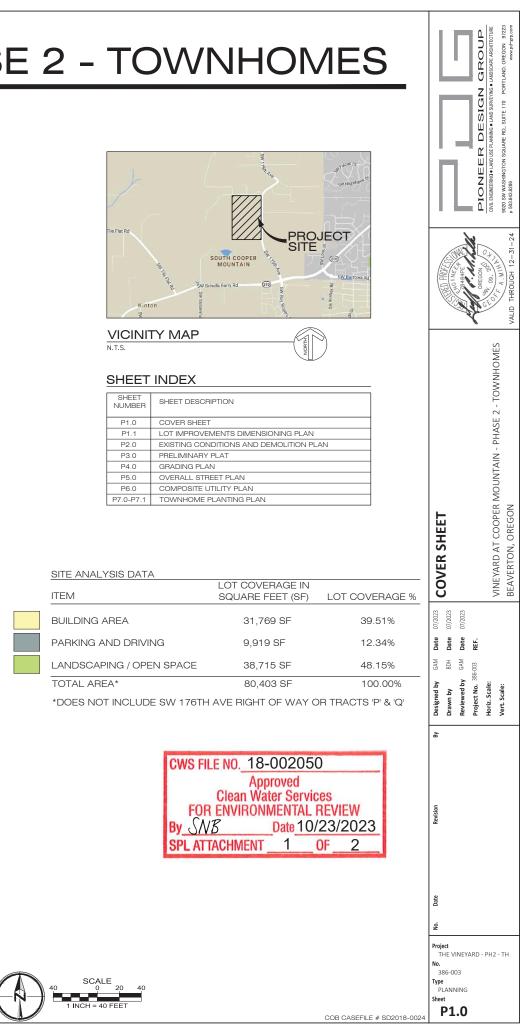



olects/235-048/planning/Townhomes/Phase 2/23548 1.1 dimplan-PH2-Townhome.dwg 10/16/2023 5.25.36 Ph



\_\_\_\_\_

-----

#### LEGEND

PROPOSED CONCRETE CURB AND GUTTER SAWCUT LINE EASEMENT LINE EXISTING PAVEMENT

PROPOSED PAVEMENT

PROPOSED SIDEWALK WITH FACILITY PERMIT

PROPOSED SIDEWALK (BY HOMEBUILDER)







P1.1

SCAL



CleanWater Services

CWS File Number

**AMENDED Service Provider Letter** 

18-002050

This form and the attached conditions will serve as your Service Provider Letter in accordance with Clean Water Services Design and Construction Standards (R&O 19-5).

Jurisdiction:	City of Beaverton	Review Type:	Tier 2 Analysis	
		SPL Original Date:	August 16, 2018	
Site Address	17520 SW Horse Tale Dr	SPL Amendment Date:	May 20, 2019	
/ Location:	Location: Beaverton, OR 97007 SPL Expiration Date:		May 19, 2021	
Applicant Infor	mation:	Owner Information:		
Name	DARREL SMITH	Name		
Company	METROPOLITAN LAND GROUP LLC	Company METRO	POLITAN LAND GROUP LLC	
Address	17933 NW EVERGREEN PARKWAY BEAVERTON OR 97006		W EVERGREEN PARKWAY	
/ laulooo	SUITE 300	Address <u>BEAVER</u> SUITE 3	RTON OR 97006	
Phone/Fax	(503) 597-7100	Phone/Fax (503) 59	7-7100	
E-mail:		E-mail:		
1S13100016	Tax lot ID	Devel	opment Activity	
1900		Vineyard at Cooper Mo	untain Subdivision	
2S106B0002				
Pre	-Development Site Conditions:	Post Develo	pment Site Conditions:	
Sensitive Area P	resent: X On-Site X Off-Site	Sensitive Area Present:		
Vegetated Corric		Vegetated Corridor Width:	X On-Site Soft-Site	
Vegetated Corric	has not set of the second s		Vallable	
Enhancement o	f Remaining			
Vegetated Corri		Square Footage to be en	hanced: 160,907	
	Encroachments into Pre-Dev	velopment Vegetated Corridor		
Type and locatio	n of Encroachment:		Square Footage:	
Roads, Trail, Sto	rmwater Facility (Permanent Encroachment; Mi	tigation Required)	29,800	
Off-site Regional	Stormwater Facility (Permanent Encroachmen	t; Mitigated through PTP)	29,800 19,391	
Off-site Regional	Stormwater Facility (Permanent Encroachmen s (Temporary Encroachment; Restoration Plant	t; Mitigated through PTP) ing In-place Required)	29,800	
Off-site Regional Stormwater Pipe	Stormwater Facility (Permanent Encroachmen s (Temporary Encroachment; Restoration Plant	t; Mitigated through PTP)	29,800 19,391	
Off-site Regional Stormwater Pipe	Stormwater Facility (Permanent Encroachmen s (Temporary Encroachment; Restoration Plant <b>Mitigation R</b>	t; Mitigated through PTP) ing In-place Required)	29,800 19,391	
Off-site Regional Stormwater Pipe	Stormwater Facility (Permanent Encroachmen s (Temporary Encroachment; Restoration Plant <b>Mitigation R</b>	t; Mitigated through PTP) ing In-place Required)	29,800 19,391 2,996	
Off-site Regional	Stormwater Facility (Permanent Encroachmen s (Temporary Encroachment; Restoration Plant <b>Mitigation R</b>	t; Mitigated through PTP) ing In-place Required)	29,800 19,391 2,996 Sq. Ft./Ratio/Cost	
Off-site Regional Stormwater Pipe Type/Location On-site (1S13100	Stormwater Facility (Permanent Encroachmen s (Temporary Encroachment; Restoration Plant Mitigation R 201600, 1605)	t; Mitigated through PTP) ing In-place Required) equirements:	29,800 19,391 2,996 Sq. Ft./Ratio/Cost 44,700 / 1.5:1	
Off-site Regional Stormwater Pipe Type/Location On-site (1S13100	Stormwater Facility (Permanent Encroachmen s (Temporary Encroachment; Restoration Plant <b>Mitigation R</b>	t; Mitigated through PTP) ing In-place Required) equirements: (5) Planting Plan Attached	29,800 19,391 2,996 Sq. Ft./Ratio/Cost 44,700 / 1.5:1 Geotech Report Required	

## **ALTERNATIVES ANALYSIS**

#### 1. The proposed encroachment area is mitigated in accordance with Section 3.08.

The proposed site plan will impact both wetland and CWS VC due to retaining walls, roadway and trail crossings and for a regional stormwater facility. The stormwater facility VC impacts totaling 19,391 square feet will be mitigated through Payment-to-Provide (PTP), which is \$0 since the associated wetlands are isolated and will be mitigated through purchase of wetland mitigation bank credits. The VC impacts associated with the retaining walls, roadway and trail impacts totaling 29,800 square feet will be mitigated on site along the perimeter of the main drainage VC. The total on-site mitigation provided will be 44,700 square feet, which is 1.5 to 1 ratio of mitigation to impact.

# 2. The replacement mitigation protects the functions and values of the Vegetated Corridor and Sensitive Area.

VC functions impacted at the road and trail crossings and retaining walls for development will be mitigated on site along the existing drainage. This mitigation will be contiguous with the existing CWS VC enhancement areas and will provide for wider VC along approximately 1,500 linear feet of the drainage. The VC and wetland functions lost with the elimination of Wetland D and E in the storm water facility footprint will be provided by the purchase of mitigation bank credits. The mitigation bank credits will offset the lost wetland functions, which are minimal in the small slope wetlands. Elimination of the VC along the wetlands will not greatly impact the existing function of the local watershed, since impacted VC functions are isolated at the slope wetlands and will be replaced directly adjacent to the drainage corridor in middle site.

- 3. Enhancement of the replacement area, if not already in Good Corridor Condition, and either the remaining Vegetated Corridor on the site or the first 50 feet of width closest to the resource, whichever is less, to a Good Corridor Condition. A total of 163,204 square feet of existing VC will be enhanced along the main drainage on site to district standards.
- 4. A District Stormwater Connection Permit is likely to be issued based on proposed plans. The project engineer has submitted a preliminary storm drainage report with the land use application to the City. Upon acceptance of the Tier 2, construction plans with the proposed storm water treatment plan will be submitted with the goal to achieve a Stormwater Connection Permit.
- 5. Location of development and site planning minimizes incursion into the Vegetated Corridor. All of the wetland and waterway and associated VC impacts result from retaining wall, roadways, trails or storm water facilities. The multi-use trail is a requirement of the Beaverton regional trail plan, and THPRD regulations apply to trail design. Overall VC encroachment due to the trail has been minimized to the maximum extent practicable and uses existing culvert crossings where available and the unavoidable road crossing impacts will be minimized by curb- tight sidewalks to reduce the roadway widths. The eastern neighborhood storm facility avoids significant wetland impacts on the THPRD property to the south. The applicant cannot avoid the direct impacts to wetlands and associated VC and still construct the road infrastructure and neighborhood storm facilities.

# 6. No practicable alternative to the location of the development exists that will not disturb the Sensitive Area or Vegetated Corridor.

The preferred alternative provides the neighborhood and collector routes through the site to meet the City of Beaverton SCMCP requirements. The integration of the eastern neighborhood storm facility with the THRPD park improvements in southeast end of site meets required vehicular access to future THPRD park, since access off of SW 175<sup>th</sup> Avenue is not allowed by Beaverton and THPRD. The preferred alternative provides the regional stormwater facility in a location that can serve both the eastern portion of the Vineyard development and the future THPRD park site. While the retaining wall, roadway and trail structures will impact the wetlands in the drainage swale in the middle of the site, these impacts are unavoidable in order to provide the neighborhood and collector routes through the site and the meet transportation requirements of Beaverton's SCMCP. The wetland impacts resulting from the storm facility are also unavoidable since the facility must be located in the topographic low point of the site. The site plan alternative that looked at reductions in wetland and CWS VC impacts is not practicable, since it cannot meet the roadway alignment requirements and does not meet vehicular access requirements to the THPRD site in the south end of site

File

#### 7. Proposed encroachment provides public benefits.

The site plan provides a 44,700 square foot VC mitigation area along the perimeter of the existing drainage corridor on site. This mitigation will provide approximately 1,500 linear feet of expanded VC from the minimum 50-foot width so that proposed VC widths average 25 feet additional VC width adjacent to the proposed development. The increased VC along this drainage corridor will provide water quality public benefit to serve the surrounding South Cooper Mountain and downstream Tualatin River watershed.

# In order to comply with Clean Water Services water quality protection requirements the project must comply with the following conditions:

- No structures, development, construction activities, gardens, lawns, application of chemicals, uncontained areas of hazardous materials as defined by Oregon Department of Environmental Quality, pet wastes, dumping of materials of any kind, or other activities shall be permitted within the sensitive area or Vegetated Corridor which may negatively impact water quality, except those allowed in R&O 17-5, Chapter 3.
- 2. Prior to any site clearing, grading or construction the Vegetated Corridor and water quality sensitive areas shall be surveyed, staked, and temporarily fenced per approved plan. During construction the Vegetated Corridor shall remain fenced and undisturbed except as allowed by R&O 17-5, Section 3.06.1 and per approved plans.
- 3. Prior to any activity within the sensitive area, the applicant shall gain authorization for the project from the Oregon Department of State Lands (DSL) and US Army Corps of Engineers (USACE). The applicant shall provide Clean Water Services or its designee (appropriate city) with copies of all DSL and USACE project authorization permits.
- 4. An approved Oregon Department of Forestry Notification is required for one or more trees harvested for sale, trade, or barter, on any non-federal lands within the State of Oregon.
- 5. Prior to ground disturbing activities an erosion control permit is required. Appropriate Best Management Practices (BMP's) for Erosion Control, in accordance with Clean Water Services' Erosion Prevention and Sediment Control Planning and Design Manual, shall be used prior to, during, and following earth disturbing activities.
- 6. Prior to construction, a Stormwater Connection Permit from Clean Water Services or its designee is required pursuant to Ordinance 27, Section 4.B.
- 7. Activities located within the 100-year floodplain shall comply with R&O 17-5, Section 5.10.
- 8. Removal of native, woody vegetation shall be limited to the greatest extent practicable.
- 9. The water quality swale and detention pond shall be planted with Clean Water Services approved native species, and designed to blend into the natural surroundings.
- 10. Should final development plans differ significantly from those submitted for review by Clean Water Services, the applicant shall provide updated drawings, and if necessary, obtain a revised Service Provider Letter.
- 11. The Vegetated Corridor width for sensitive areas within the project site shall be a minimum of 50 feet wide, as measured horizontally from the delineated boundary of the sensitive area.
- 12. For Vegetated Corridors up to 50 feet wide, the applicant shall enhance the entire Vegetated Corridor to meet or exceed good corridor condition as defined in R&O 17-5, Section 3.14.2, Table 3-3.
- 13. Removal of invasive non-native species by hand is required in all Vegetated Corridors rated ""good."" Replanting is required in any cleared areas larger than 25 square feet using low impact methods. The applicant shall calculate all cleared areas larger than 25 square feet prior to the preparation of the required Vegetated Corridor enhancement/restoration plan.
- 14. Prior to any site clearing, grading or construction, the applicant shall provide Clean Water Services with a Vegetated Corridor enhancement/restoration plan. Enhancement/restoration of the Vegetated Corridor shall be provided in accordance with R&O 17-5, Appendix A, and shall

include planting specifications for all Vegetated Corridor, including any cleared areas larger than 25 square feet in Vegetated Corridor rated "good.""

- 15. Prior to installation of plant materials, all invasive vegetation within the Vegetated Corridor shall be removed per methods described in Clean Water Services' Integrated Vegetation and Animal Management Guidance, 2003. During removal of invasive vegetation care shall be taken to minimize impacts to existing native tree and shrub species.
- Clean Water Services shall be notified 72 hours prior to the start and completion of enhancement/restoration activities. Enhancement/restoration activities shall comply with the guidelines provided in Planting Requirements (R&0 17-5, Appendix A).
- 17. Maintenance and monitoring requirements shall comply with R&O 17-5, Section 2.12.2. If at any time during the warranty period the landscaping falls below the 80% survival level, the owner shall reinstall all deficient planting at the next appropriate planting opportunity and the two year maintenance period shall begin again from the date of replanting.
- 18. Performance assurances for the Vegetated Corridor shall comply with R&O 17-5, Section 2.07.2, Table 2-1 and Section 2.11, Table 2-2.
- 19. For any developments which create multiple parcels or lots intended for separate ownership, Clean Water Services shall require that the sensitive area and Vegetated Corridor be contained in a separate tract and subject to a ""STORM SEWER, SURFACE WATER, DRAINAGE AND DETENTION EASEMENT OVER ITS ENTIRETY"" to be granted to the City or Clean Water Services.

#### **FINAL PLANS**

- 20. Final construction plans shall include landscape plans. In the details section of the plans, a description of the methods for removal and control of exotic species, location, distribution, condition and size of plantings, existing plants and trees to be preserved, and installation methods for plant materials is required. Plantings shall be tagged for dormant season identification and shall remain on plant material after planting for monitoring purposes.
- 21. A Maintenance Plan shall be included on final plans including methods, responsible party contact information, and dates (minimum two times per year, by June 1 and September 30).
- 22. Final construction plans shall clearly depict the location and dimensions of the sensitive area and the Vegetated Corridor (indicating good, marginal, or degraded condition). Sensitive area boundaries shall be marked in the field.
- 23. Protection of the Vegetated Corridors and associated sensitive areas shall be provided by the installation of permanent fencing and signage between the development and the outer limits of the Vegetated Corridors. Fencing and signage details to be included on final construction plans.


#### This Service Provider Letter is not valid unless CWS-approved site plan is attached.


Please call (503) 681-3667 with any questions.


Stacy Benjamin


Stacy Benjamin Environmental Plan Review


Attachments (5)

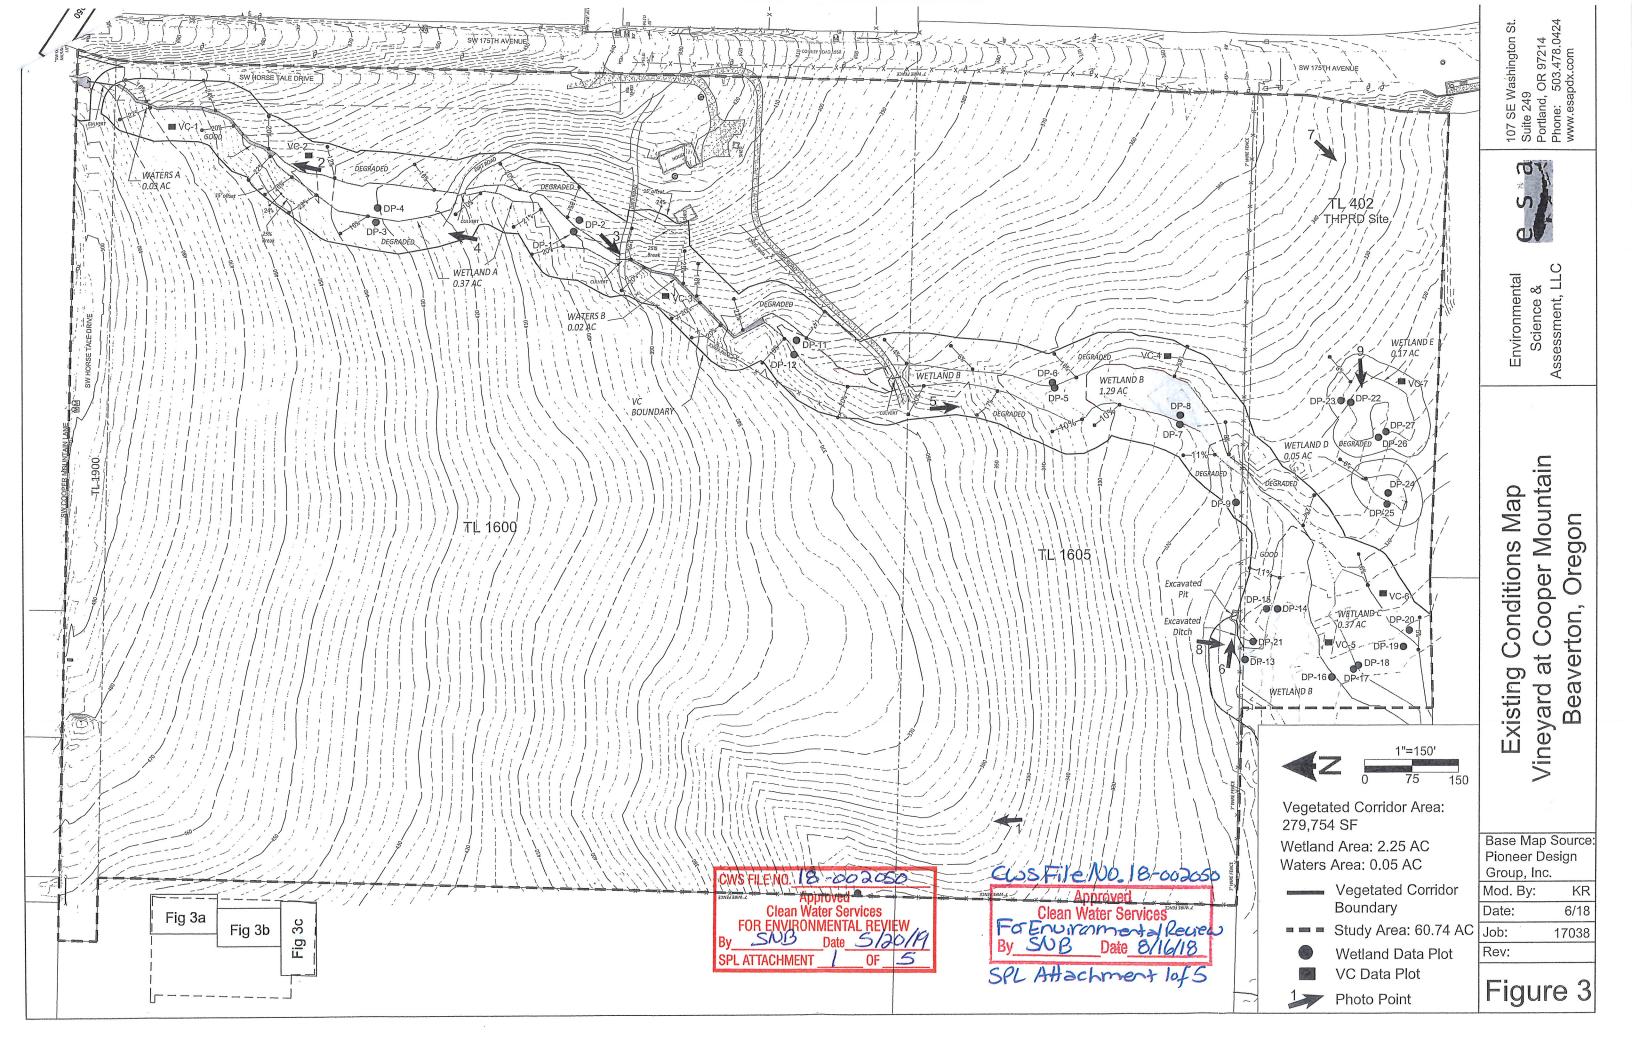

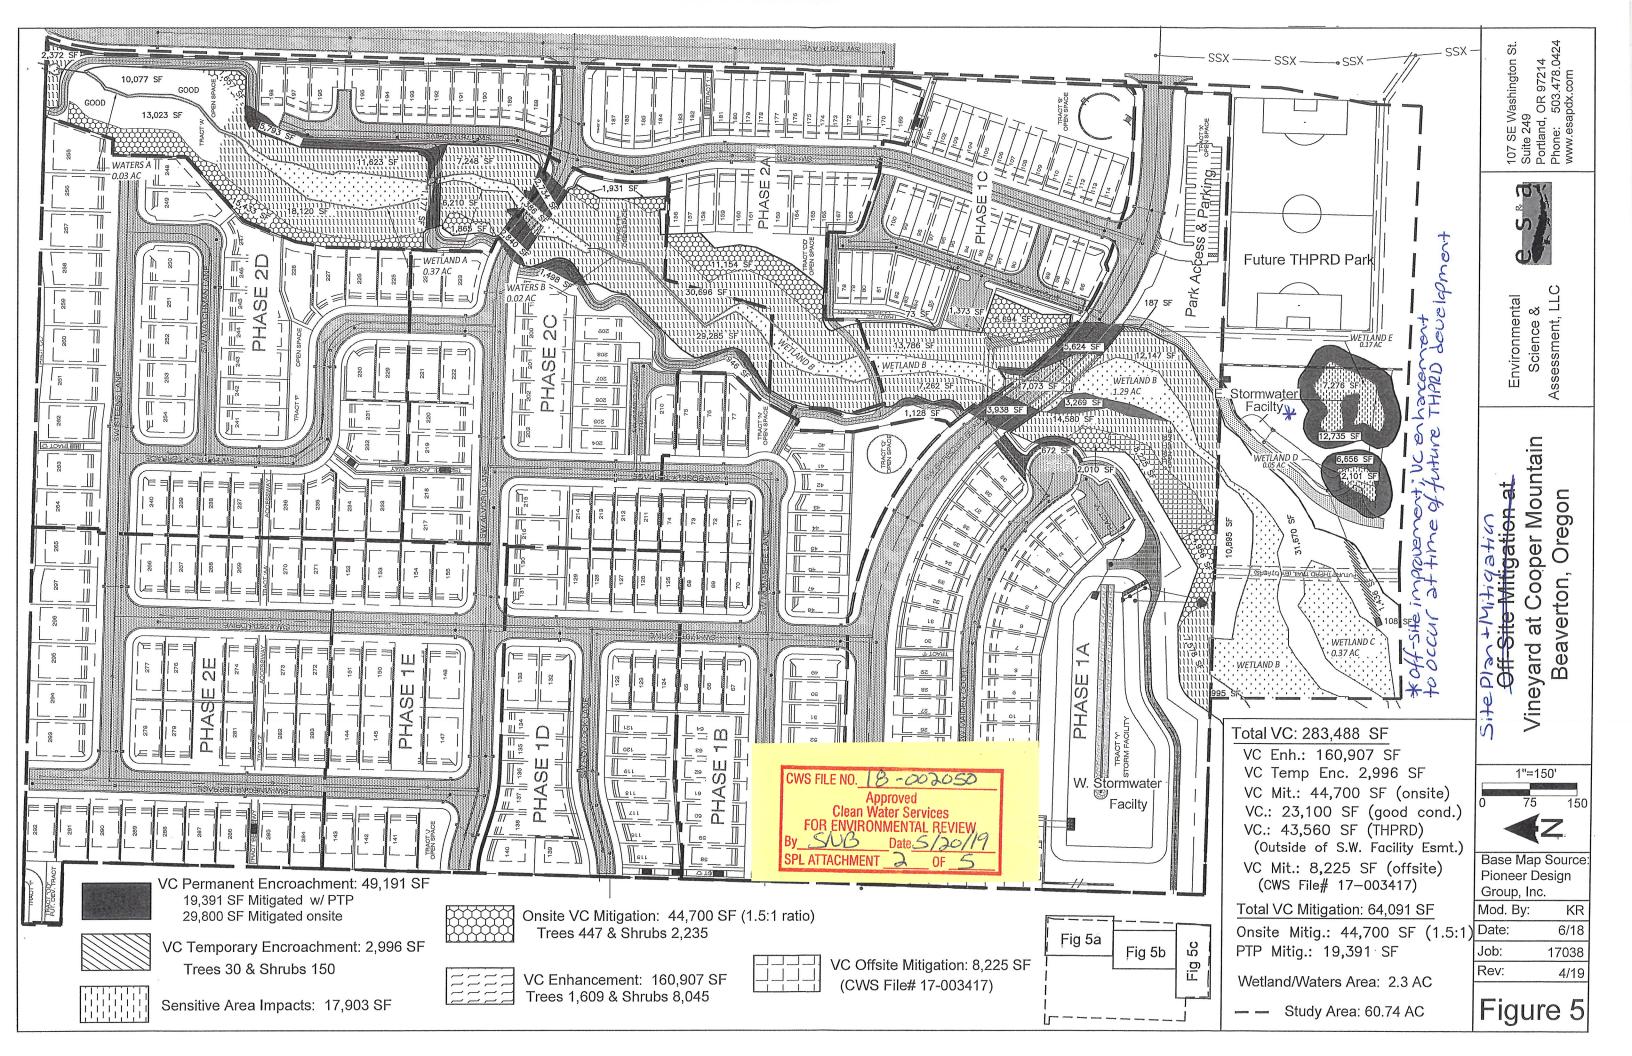

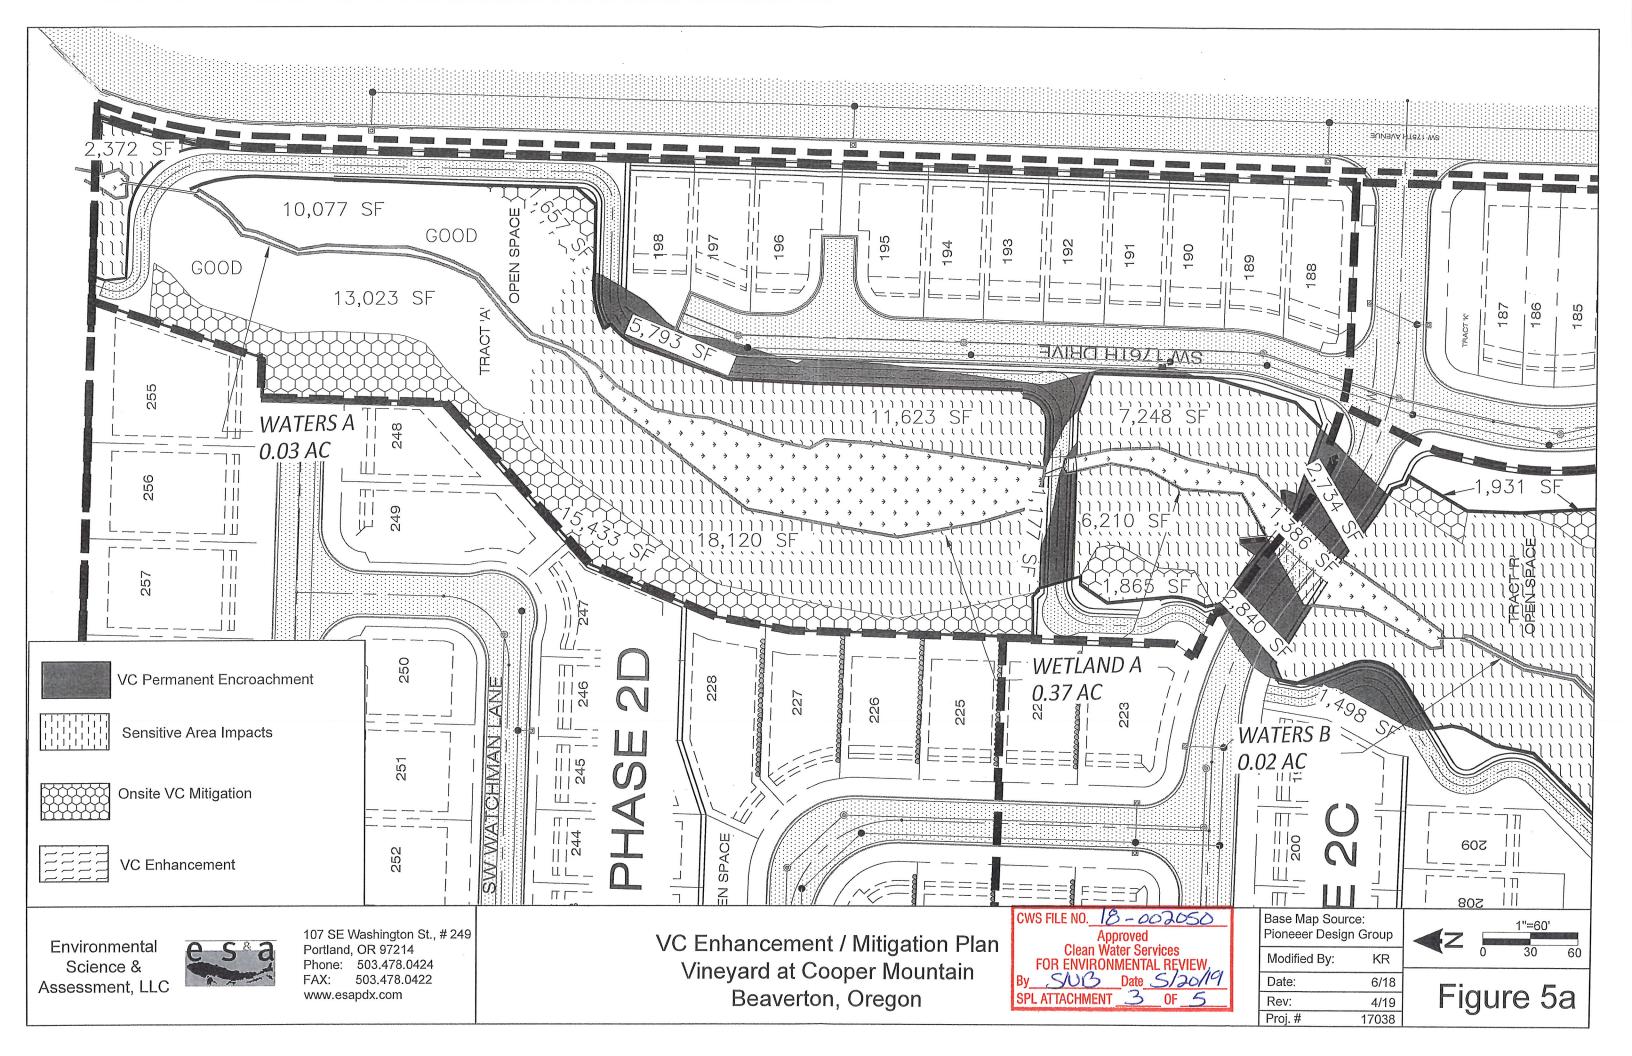

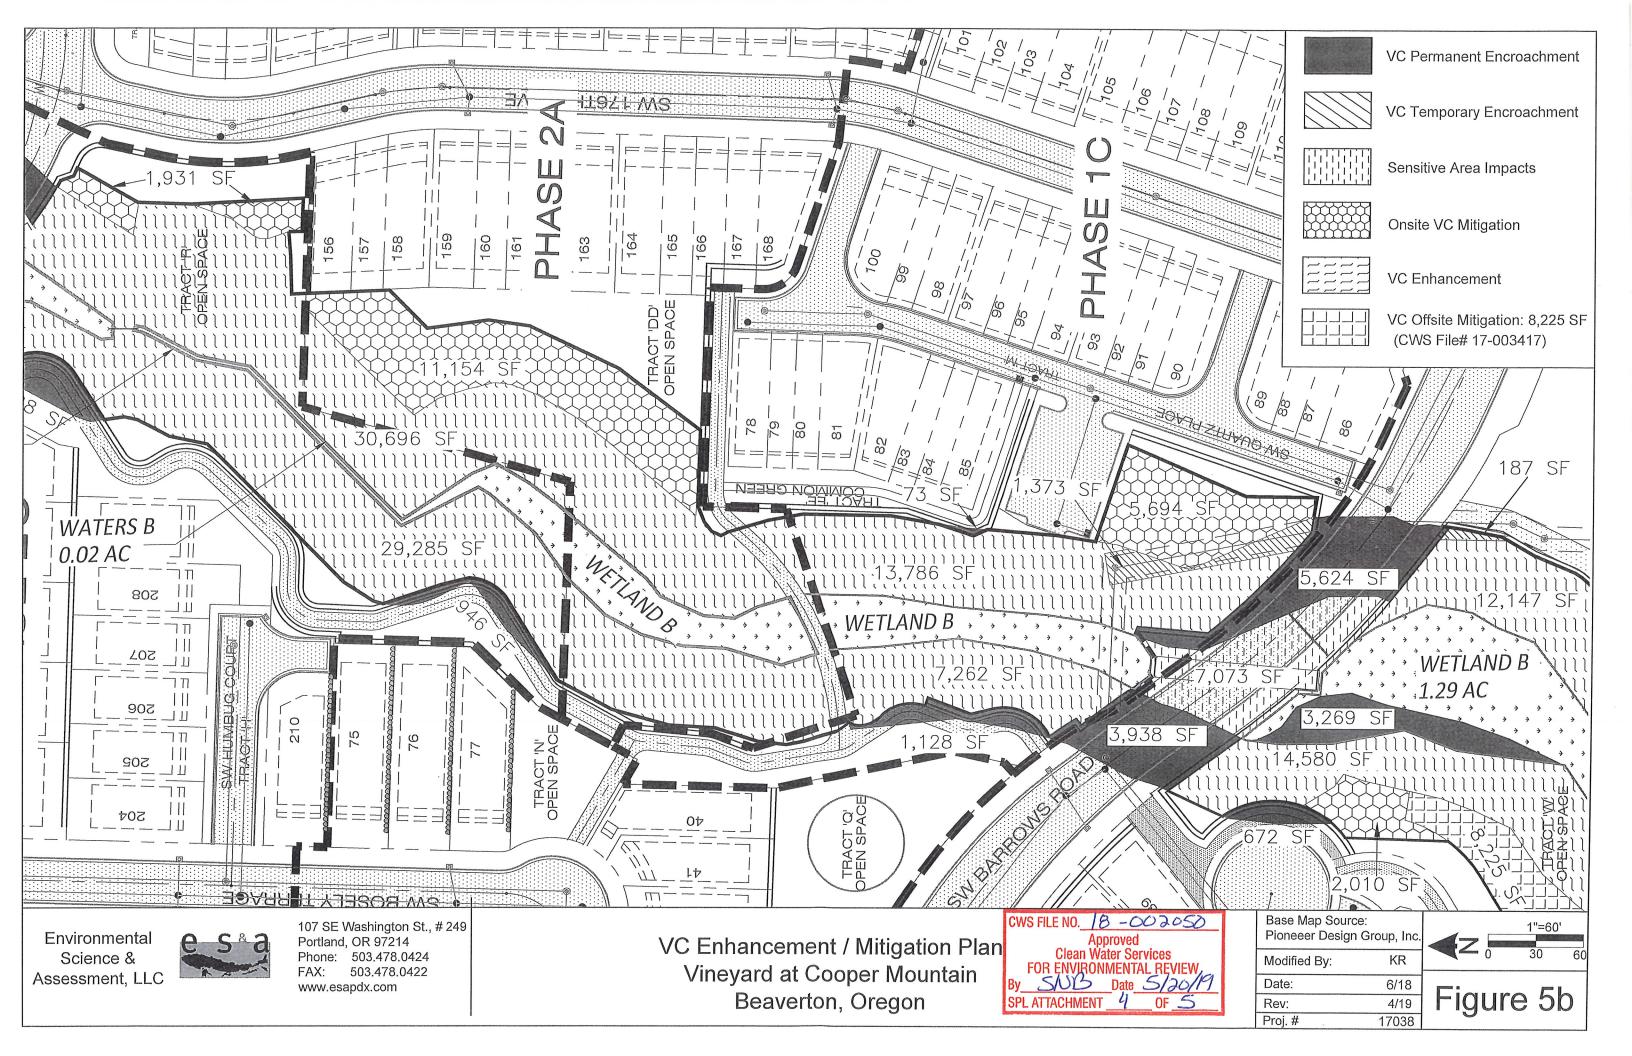

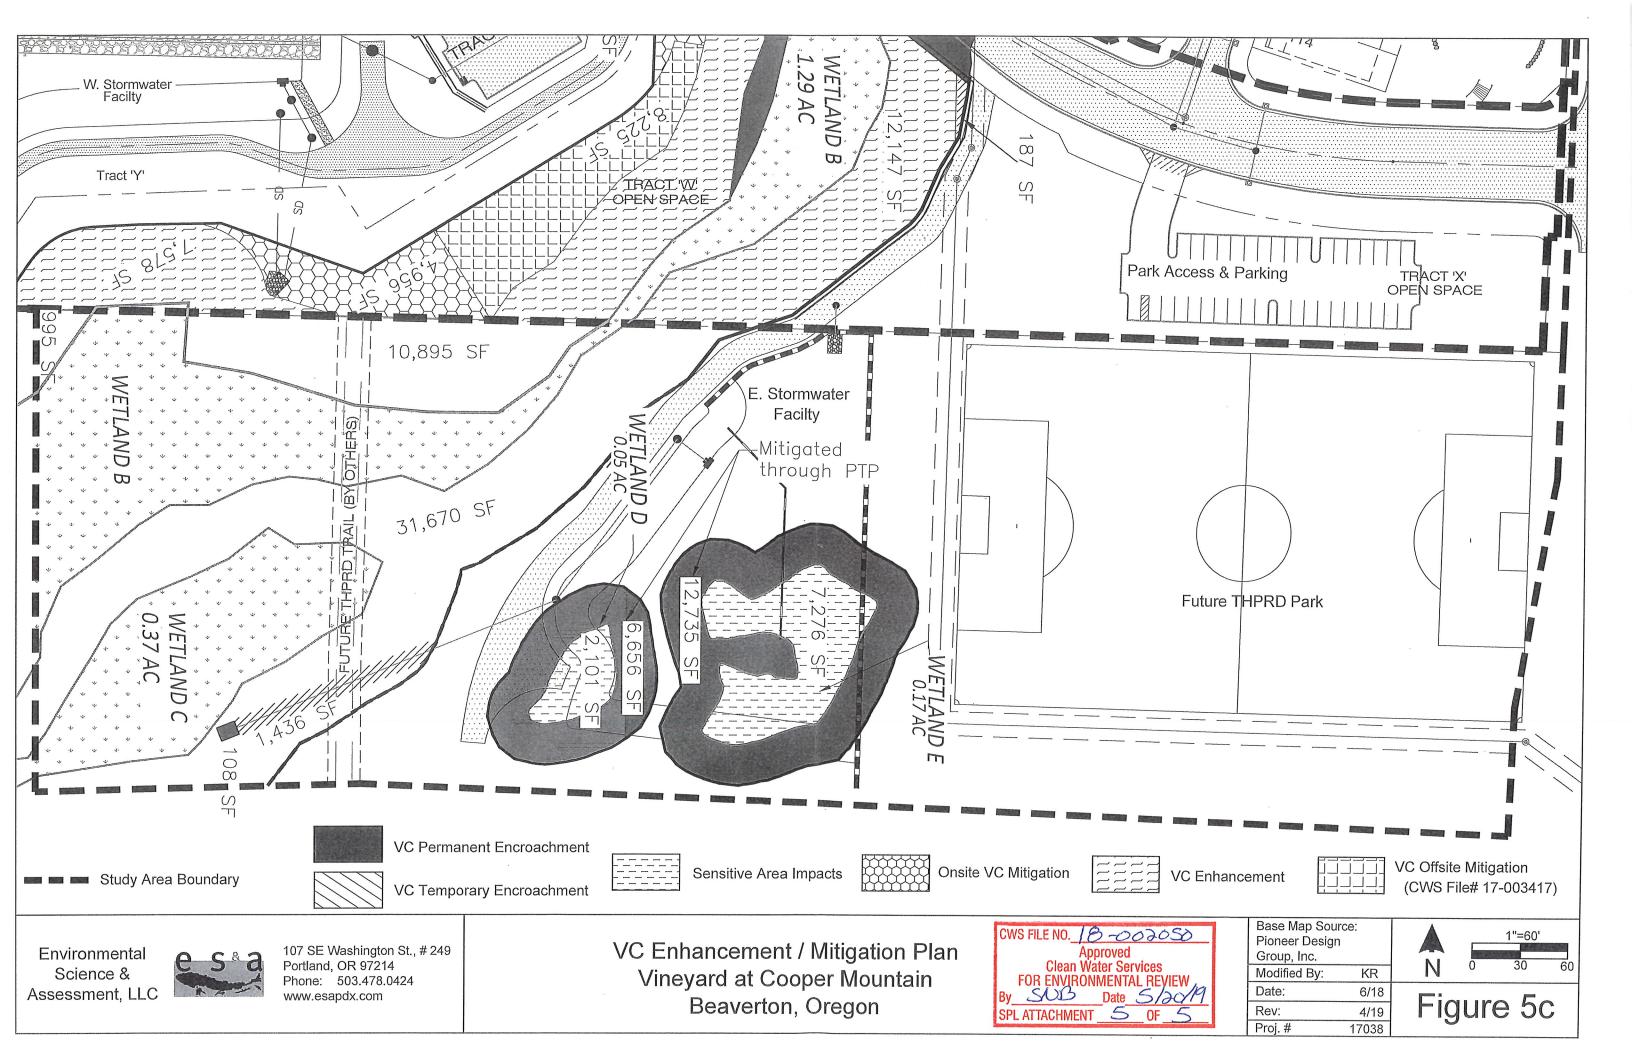



# FIRE CODE / LAND USE / BUILDING REVIEW APPLICATION

North Operating Center 11945 SW 70<sup>th</sup> Avenue Tigard, OR 97223 Phone: 503-649-8577

#### South Operating Center 8445 SW Elligsen Rd


Wilsonville, OR 97070 Phone: 503-649-8577

REV 6-30-20


Project Information	Permit/Review Type (check one):
Project Information         Applicant Name:       AG EHC II (NWHM) Multi State 2 LLC         Address:       15231 Laguna Canyon Road, Suite 250, Irvine, CA         92618	<ul> <li>Land Use / Building Review - Service Provider Permit</li> <li>Emergency Radio Responder Coverage Install/Test</li> <li>LPG Tank (Greater than 2,000 gallons)</li> <li>Flammable or Combustible Liquid Tank Installation (Greater than 1,000 gallons)</li> <li>* Exception: Underground Storage Tanks (UST) are deferred to DEQ for regulation.</li> <li>Explosives Blasting (Blasting plan is required)</li> <li>Exterior Toxic, Pyrophoric or Corrosive Gas Installation (in excess of 810 cu.ft.)</li> </ul>
Business Name:       Ine New Home Company         Land Use/Building Jurisdiction:       City of Beaverton         Land Use/ Building Permit # SD2023-0007 / LD2018-0026	<ul> <li>Tents or Temporary Membrane Structures (in excess of 10,000 square feet)</li> <li>Temporary Haunted House or similar</li> </ul>
Choose from: Beaverton, Tigard, Newberg, Tualatin, North Plains, West Linn, Wilsonville, Sherwood, Rivergrove, Durham, King City, Washington County, Clackamas County, Multnomah County, Yamhill County	<ul> <li>OLCC Cannabis Extraction License Review</li> <li>Ceremonial Fire or Bonfire (For gathering, ceremony or other assembly)</li> </ul>
Project Description Construction of 32 townhome units in 8 separate townhome buildings on Lots 156 – 174 and 186 – 198 of the Vineyard Phase 2 subdivision	For Fire Marshal's Office Use OnlyTVFR Permit # $2023-0170$ Permit Type: $SPP-CoB$ Submittal Date: $10/17/2023$ Assigned To: $DFm$ Descreta $11/2$ Due Date: $11/2$ Fees Due: $-0$ Fees Paid: $0$

Approval/Inspection Conditions	
(For Fire Marshal's Office Use Only)	ŧ


This section is for application approval only	This section used when site inspection is required
DFm Jereny foster Habit 11/1/23 Fire Marshal or Designee Date Conditions: Final ENSPection Reguired by TURGR	Inspection Comments:
See Attached Conditions: □ Yes □ No Site Inspection Required: Ø Yes □ No	
	Final TVFR Approval Signature & Emp ID Date

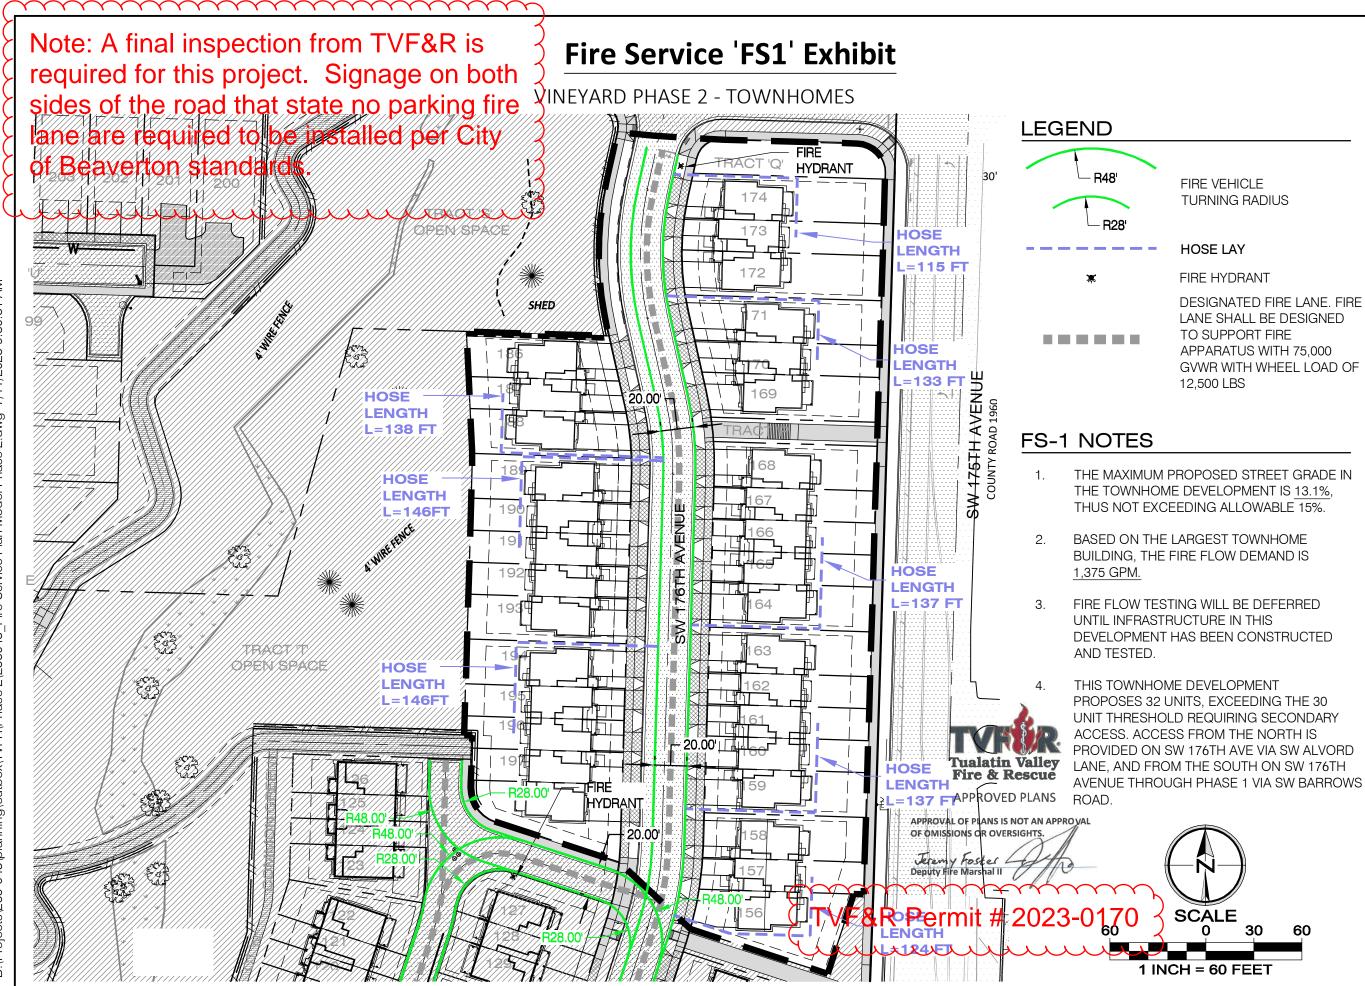

DESIGNATED FIRE LANE. FIRE LANE SHALL BE DESIGNED APPARATUS WITH 75,000 GVWR WITH WHEEL LOAD OF

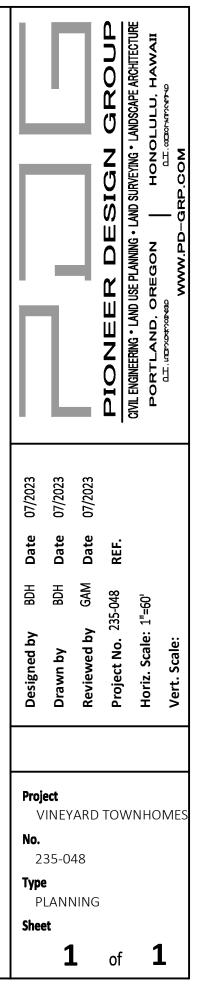

# **Fire Service 'FS2' Exhibit**

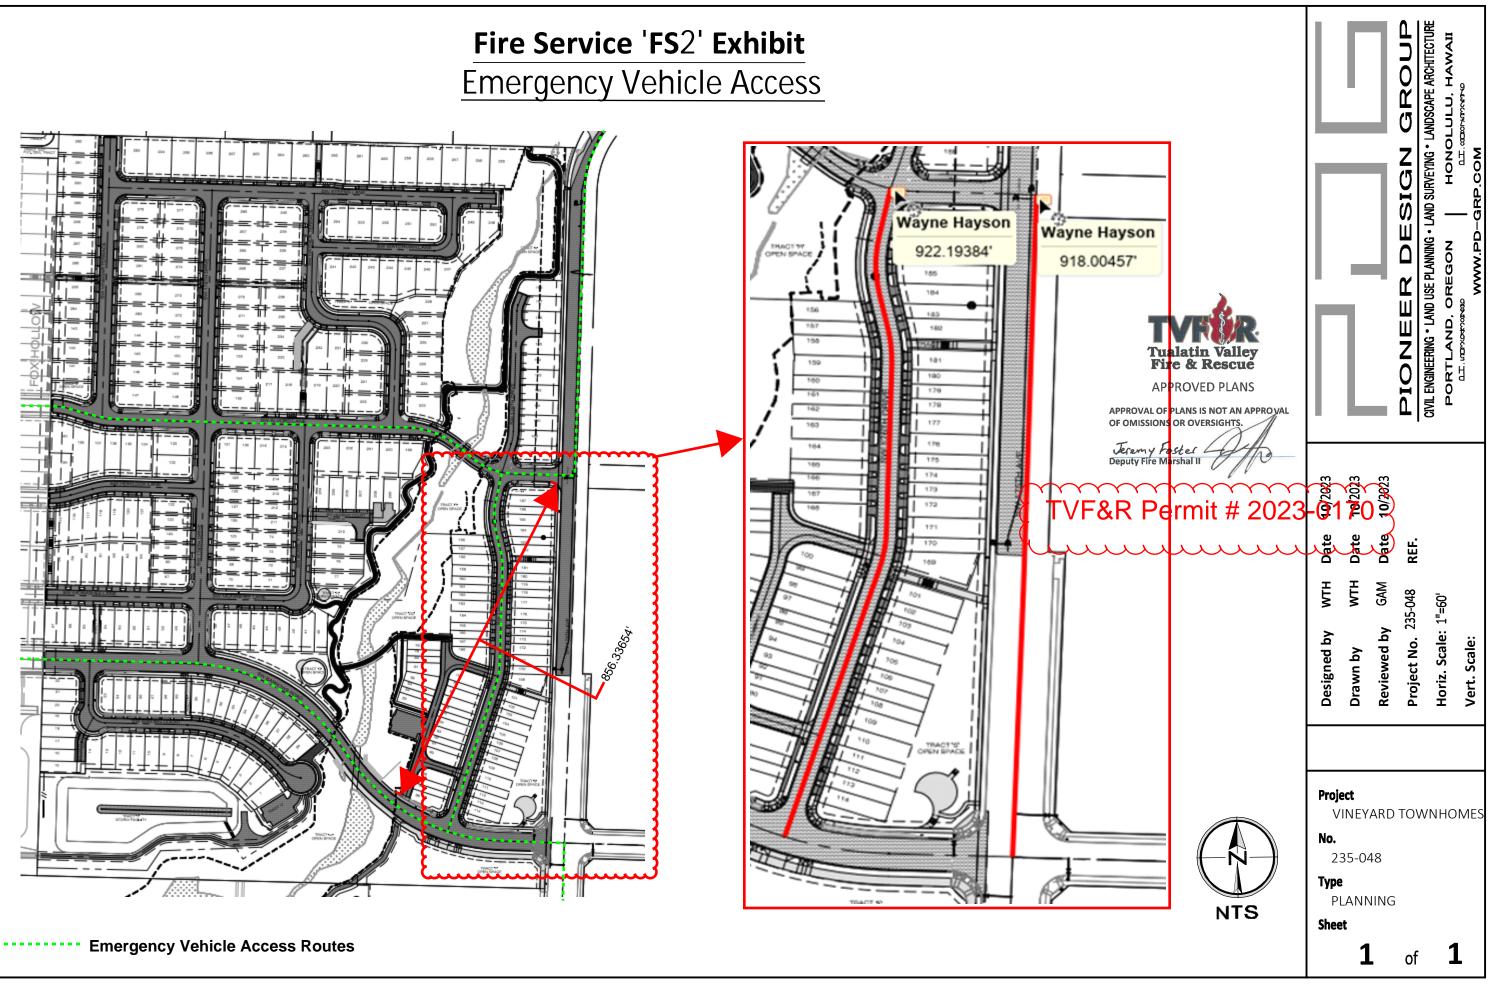

# VINEYARD AT COOPER MOUNTAIN

# APPLICANT

LC VINEYARD, LLC 17993 NW EVERGREEN PLACE, SUITE 300 BEAVERTON, OR 97006 PHONE (503) 597-7132 CONTACT: DARREL SMITH

# PLANNING

PIONEER DESIGN GROUP, INC. 9020 SW WASHINGTON SQ RD., SUITE 170 PORTLAND, OR 97223 PHONE (503) 643-8286 CONTACT: MATT SPRAGUE/WAYNE HAYSON

# ENGINEERING

PIONEER DESIGN GROUP, INC. 9020 SW WASHINGTON SQ RD., SUITE 170 PORTLAND, OR 97223 PHONE (503) 643-8286 CONTACT: GEOFF MIHALKO, PE

# SURVEYING

PIONEER DESIGN GROUP, INC. 9020 SW WASHINGTON SQ RD., SUITE 170 PORTLAND, OR 97223 PHONE (503) 643-8286 CONTACT: MIKE HARRIS, PLS

# LANDSCAPE ARCHITECT

PIONEER DESIGN GROUP, INC. 9020 SW WASHINGTON SQ RD., SUITE 170 PORTLAND, OR 97223 PHONE (503) 643-8286 CONTACT: BEN HOLMES, PLA

# BIOLOGIST

ENVIRONMENTAL SCIENCE & ASSESSMENT, LLC 107 SE WASHINGTON ST., SUITE 249 PORTLAND, OR 97202 PHONE (503) 478-0424 CONTACT: JACK DALTON

# TRAFFIC ENGINEER

KITTELSON & ASSOCIATES, INC. 610 SW ALDER ST., SUITE 700 PORTLAND, OR 97205 PHONE (503) 228-5230 CONTACT: MATT BELL

# ARBORIST


MORGAN HOLEN & ASSOCIATES, LLC 3 MONROE PARKWAY, SUITE P220 LAKE OSWEGO, OR 97035 PHONE (971) 409-9354 CONTACT: MORGAN HOLEN

# GEOTECHNICAL ENGINEER


GEOPACIFIC ENGINEERING, INC. 14835 SW 72ND AVE. PORTLAND, OR 97224 PHONE (503) 598-8445 CONTACT: JIM IMBRIE

THIS DESIGN COMPLIES WITH ORS 92.044 (7) IN THAT NO UTILITY INFRASTRUCTURE IS DESIGNED TO BE WITHIN ONE (1) FOOT OF A SURVEY MONUMENT LOCATION SHOWN ON A SUBDIVISION OR PARTITION PLAT. NO DESIGN EXCEPTIONS NOR FINAL FIELD LOCATION CHANGES SHALL BE PERMITTED IF THAT CHANGE WOULD CAUSE ANY UTILITY INFRASTRUCTURE TO BE PLACED WITHIN THE PROHIBITED AREA.



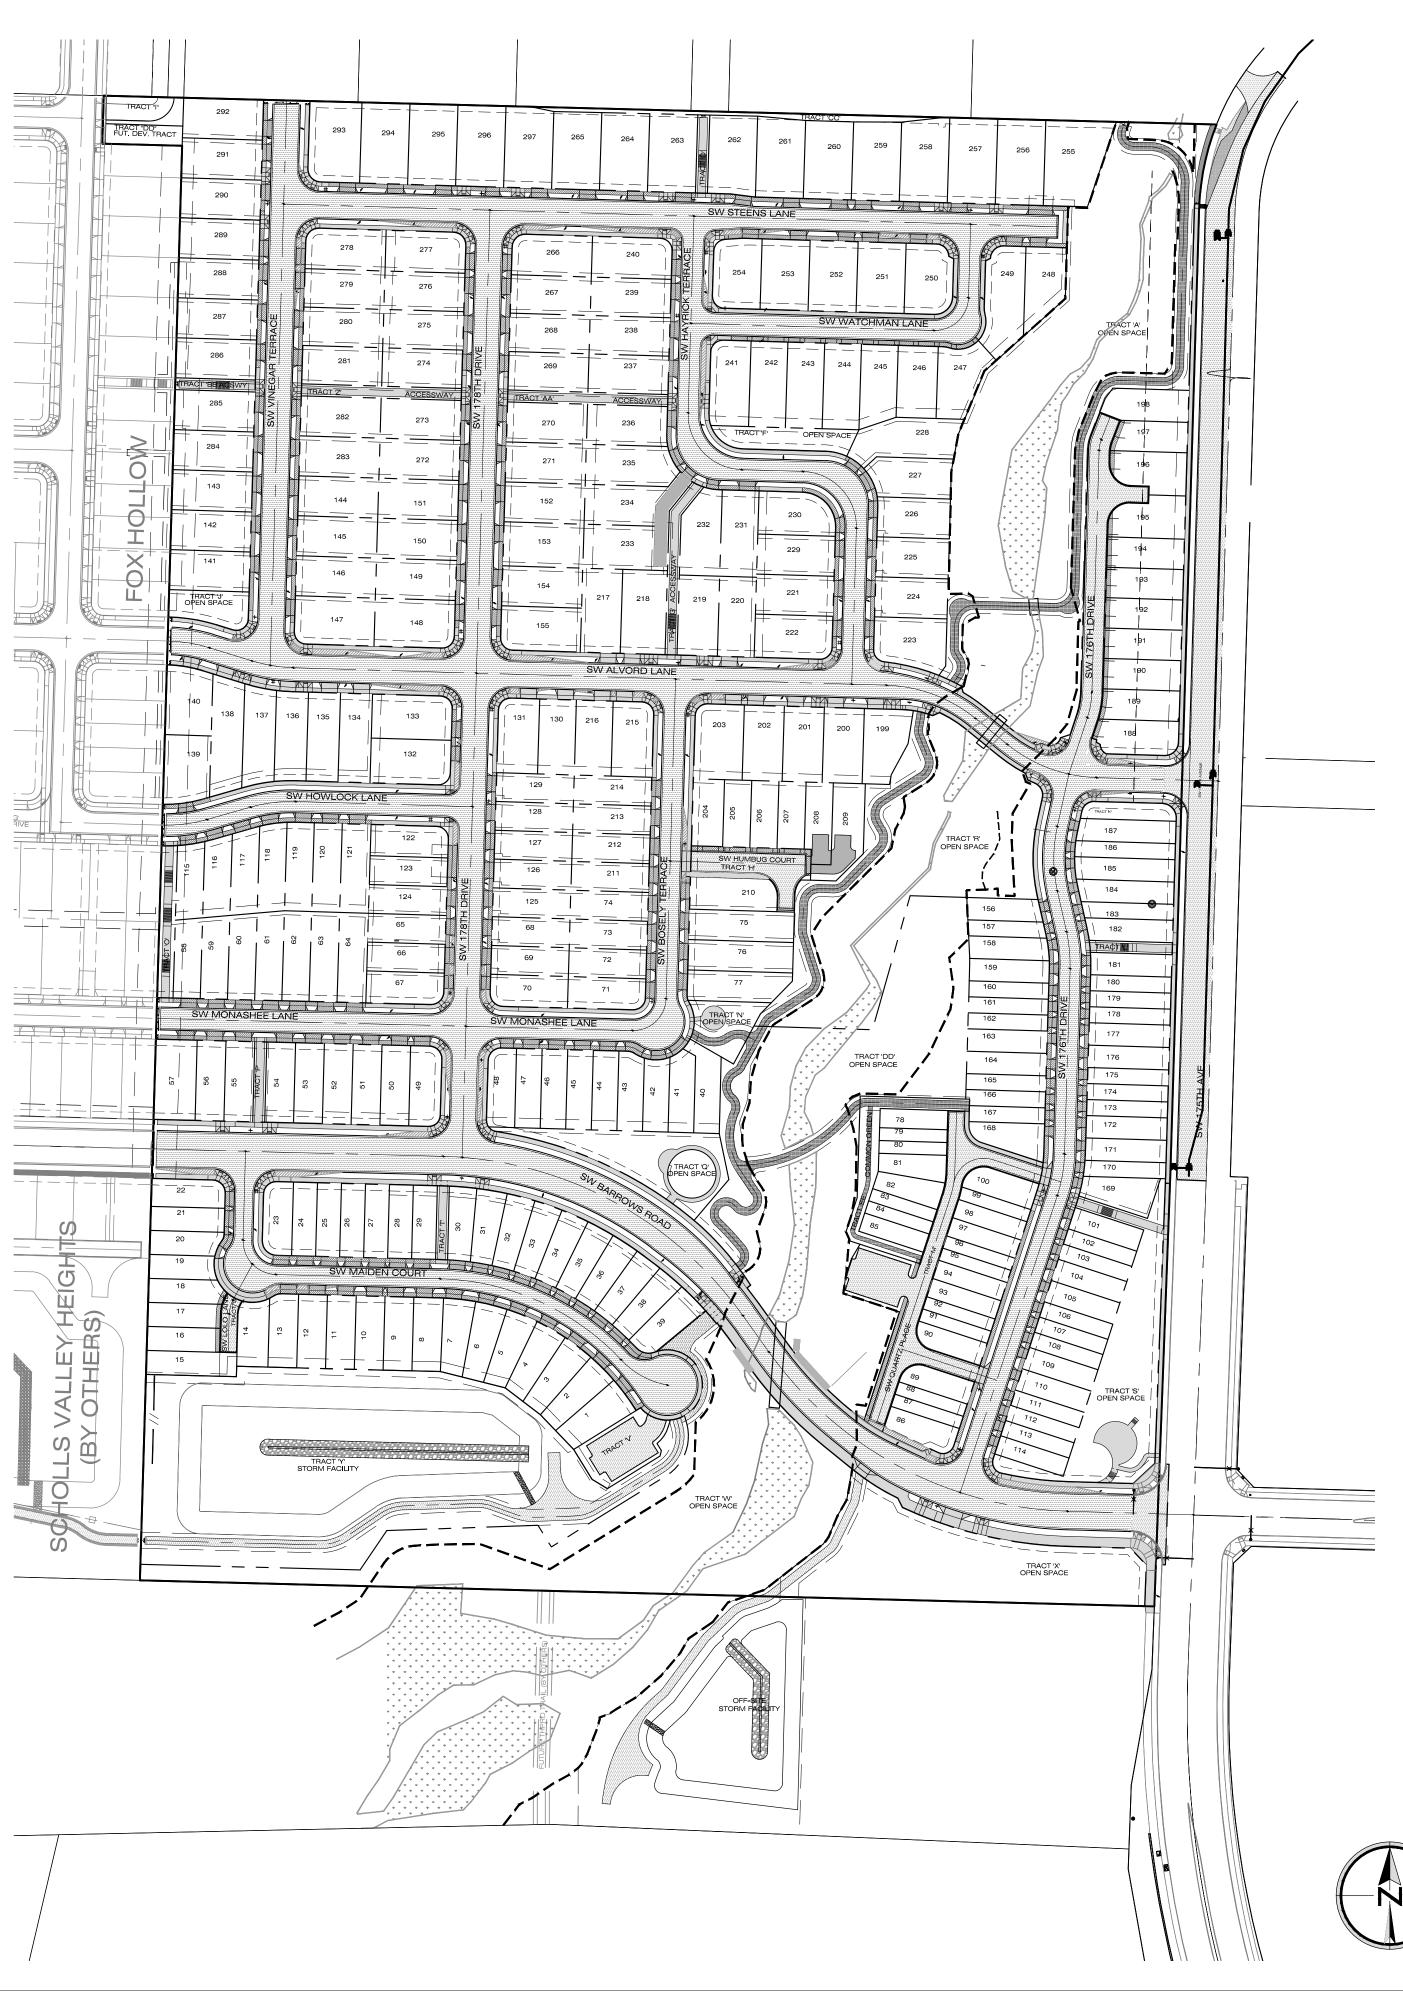

A 297 UNIT PLANNED UNIT DEVELOPMENT ON TAX LOTS 1600,& 1605, TAX MAP 1S1 31C

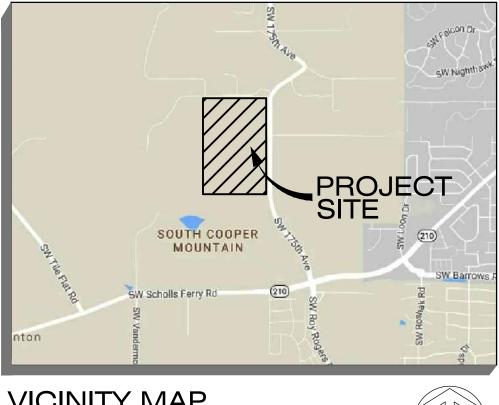

VICINITY MAP N.T.S.

# TOTAL AREA

54.28 ACRES

# LOCATION

MAP 1S1 31C, TAX LOTS 1600 & 1605

17520 SW HORSE TALE DR. BEAVERTON, OR 97007

# VERTICAL DATUM

WASHINGTON COUNTY BENCHMARK NO. 107 LOCATED ON THE SOUTH SIDE OF S.W SCHOLLS FERRY ROAD NEAR PROJECTED CENTERLINE OF S.W. 175TH AVENUE.

ELEVATION: 306.55 (NGVD 29)

# DISTURBED AREA

ONSITE OFFSITE TOTAL DISTURBED AREA

=	1,991,292 SF
=	80,238 SF
=	2,071,530 SF
	(47.55 AC)

# WASHINGTON COUNTY PERMITS

SW 175TH IMPROVEMENTS - PHASE 1 SW 175TH IMPROVEMENTS - PHASE 2 CDA#18-801

CDA#18-913

# ENVIRONMENTAL PERMITS

DSL USACE NMFS

61611RF NWP-2019-033 2013–10411

FOR OFFICIAL USE ONLY





TVF&R Permit # 2023-0170-

SCALE 0 60 120 1 INCH = 120 FEET

		1		CIVIL ENGINEERING • LAND USE PLANNING • LAND SURVEYING • LANDSCAPE ARCHITECTURE	HINGTON SQUARE RD., SUITE 170 PORTLAND, O	p 503.643.8286 www.pd-grp.com
09/27/2019	TERED PROFESS	CONGINE ENGLISH	Cheff C. M. K. K.	000 '00 'W CL	A MIHA	VALID THROUGH 12-31-20
	COVER SHEET					BEAVERION, UREGON
	by GAM	Reviewed by GAM Date 11/01/2018	Project No. 235-048 REF.	<b>Horiz. Scale:</b> $1^{"} = 120^{"}$	Vert. Scale: N/A	235048_C0.0covr.dwg
	Revision By MENTS GAM					
	No. Date 1 05/10/2019 CITY OF REAVERTON COM		ARD			

Туре

Sheet

ENGINEERING

**CO.0** 





ENHANCED SIDE ELEVATION Building 1 (Lots 156-158) CONTEMPORARY FRENCH


# MILBRANDT ARCHITECTS

The Vineyard at Cooper Mountain Beaverton, Oregon

The New Home Company



TVF&R Permit # 2023-0170

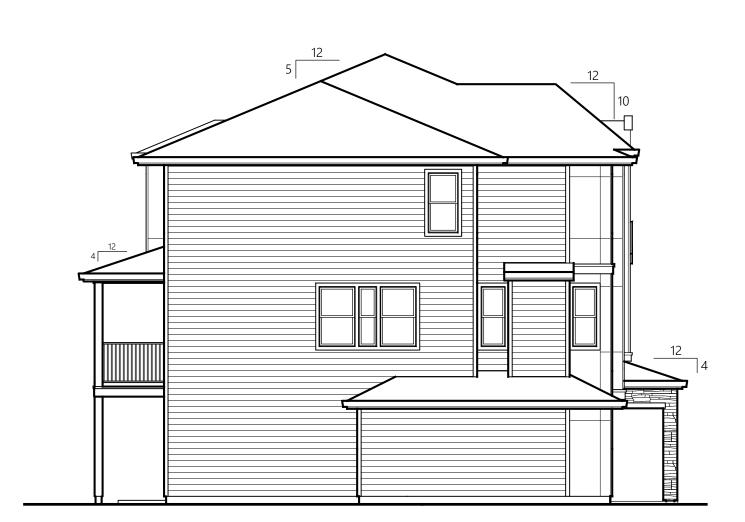


Building 1 (Lots 156-158) SIDE ELEVATION CONTEMPORARY FRENCH




Date:	10-23-23
Drawn By:	RDG
Job No.:	2320





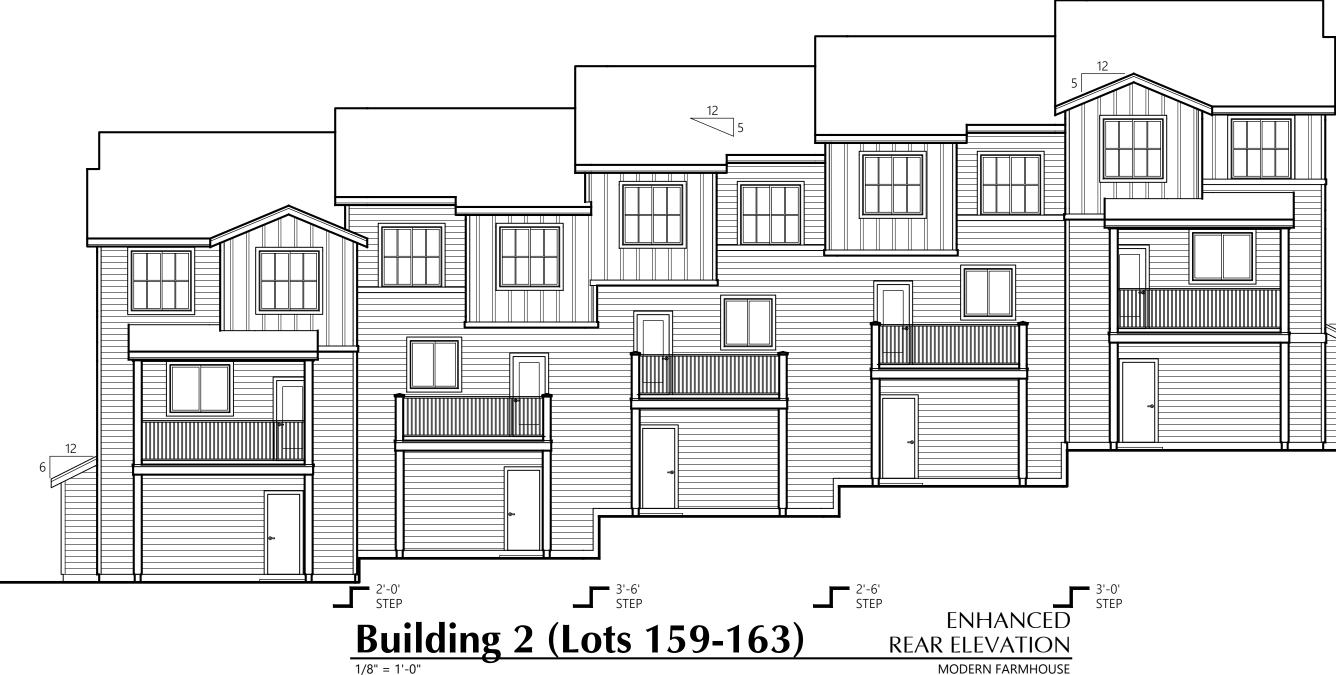

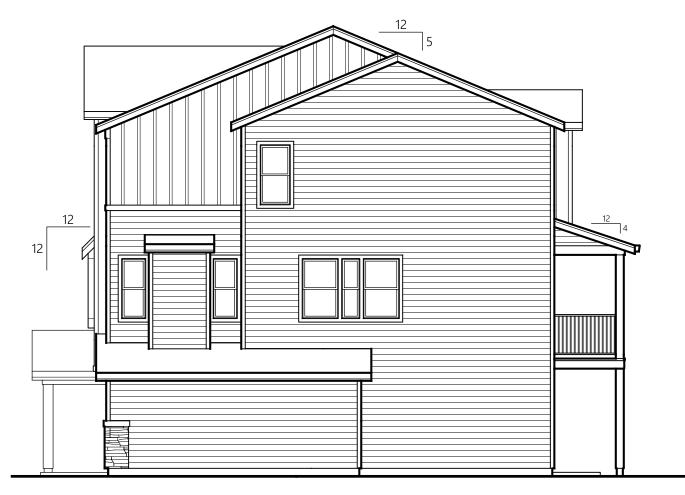

Building 2 (Lots 159-163)

SIDE ELEVATION MODERN FARMHOUSE



The Vineyard at Cooper Mountain Beaverton, Oregon

25 Central Way, Suite 210 Kirkland, WA 98033 • 425.454.7130 • WWW.MILBRANDTARCH.COM

The New Home Company

Elevations



**Building 2 (Lots 159-163)** 1/8" = 1'-0"

SIDE ELEVATION MODERN FARMHOUSE



Date:	10-23-23
Drawn By:	RDG
Job No.:	2320









Building 3 (Lots 164-168)

SIDE ELEVATION



The Vineyard at Cooper Mountain Beaverton, Oregon

The New Home Company

Elevations

CONTEMPORARY TUDOR

Building 3 (Lots 164-168)

CONTEMPORARY TUDOR

# Building 3 (Lots 164-168)

Date:	10-23-23
Drawn By:	RDG
Job No.:	2320







 Building 4 (Lots 169-171)
 ENHANCED

 1/8" = 1'-0"
 SIDE ELEVATION

# **MILBRANDT** ARCHITECTS

The Vineyard at Cooper Mountain Beaverton, Oregon




The New Home Company

Building 4 (L



# {TVF&R Permit # 2023-0170

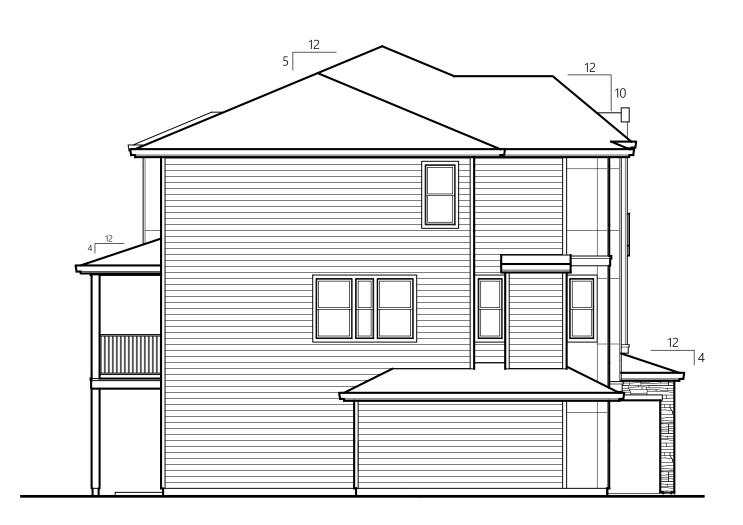

 Building 4 (Lots 169-171)
 SIDE ELEVATION


 1/8" = 1'-0"
 CONTEMPORARY FRENCH

_ots	169-171)	
ations		

Date:	10-23-23
Drawn By:	RDG
Job No.:	2320






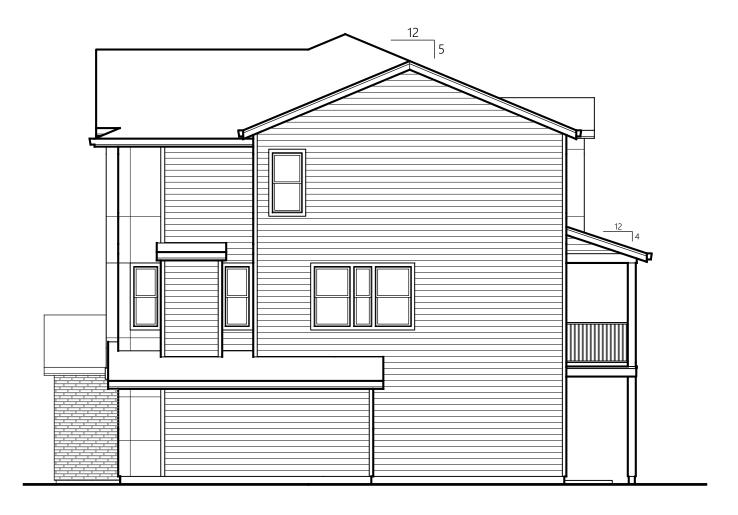

Building 5 (Lots 172-174) SIDE ELEVATION CONTEMPORARY TUDOR



The Vineyard at Cooper Mountain Beaverton, Oregon

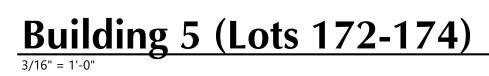

ENTRY ELEVATION CONTEMPORARY TUDOR




The New Home Company



TVF&R Permit # 2023-0170



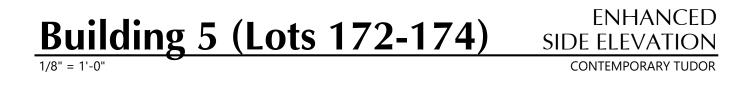


Building 5 (Lots 172-174) Elevations

Date:	10-23-23
Drawn By:	RDG
Job No.:	2320







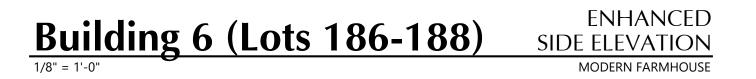

MILBRANDT ARCHITECTS

The Vineyard at Cooper Mountain Beaverton, Oregon



The New Home Company



Building 6 (Lots 186-188)


SIDE ELEVATION MODERN FARMHOUSE



Date:	10-23-23
Drawn By:	RDG
Job No.:	2320






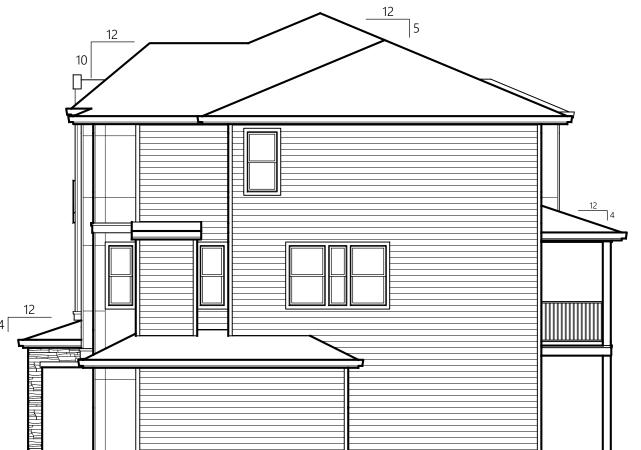



Building 7 (Lots 189-193)

SIDE ELEVATION CONTEMPORARY FRENCH

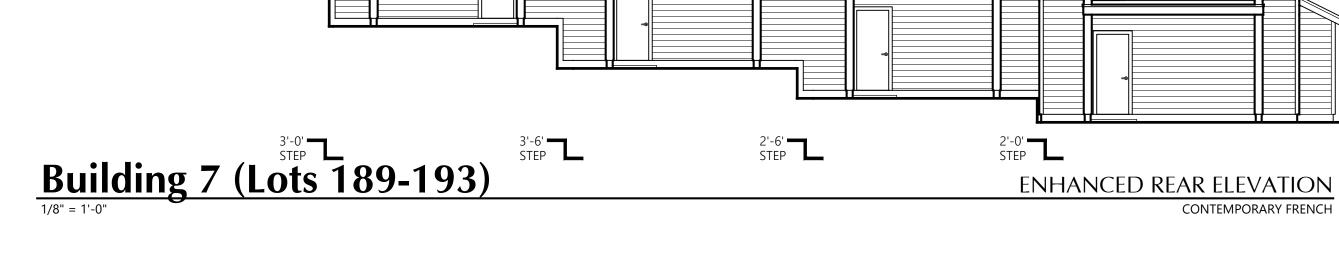



The Vineyard at Cooper Mountain Beaverton, Oregon

25 Central Way, Suite 210 Kirkland, WA 98033 • 425.454.7130 • WWW.MILBRANDTARCH.COM

The New Home Company

Elevations

CONTEMPORARY FRENCH

**Building 7 (Lots 189-193)** 1/8" = 1'-0"

SIDE ELEVATION CONTEMPORARY FRENCH



Date:	10-23-23
Drawn By:	RDG
Job No.:	2320







-----



Building 8 (Lots 194-198)

SIDE ELEVATION



The Vineyard at Cooper Mountain Beaverton, Oregon

The New Home Company

Building 8 (Lots 194-198) Elevations

Date:	10-23-23
Drawn By:	RDG
Job No.:	2320





## Wayne Hayson

From:	robert mccracken <robert_mccracken@beaverton.k12.or.us></robert_mccracken@beaverton.k12.or.us>
Sent:	Wednesday, March 01, 2023 2:57 PM
To:	Steven Sparks - Exec Admin; Wayne Hayson
Subject:	RE: Beaverton SPL Update

Hi Steve & Wayne,

I concur with Steve – the original SPL should cover this as a phase of the overall project – with no changes to unit mix, there should be no need to revise the SPL.

Would it be possible for your group to send us a breakdown of the units by phase/estimated timeline? It would be helpful for us to update our GIS about the project for internal tracking purposes – this would not affect the status of the SPL, as noted above, it would simply be for our internal use.

## **Robert McCracken, MCP**

Facilities Planning Coordinator

# Beaverton School District | Long Range Planning

1260 NW Waterhouse Ave., Beaverton, OR 97006 Office: 503-356-4319

From: Steven Sparks - Exec Admin <Steven\_Sparks@beaverton.k12.or.us>
Sent: Wednesday, March 1, 2023 2:49 PM
To: Wayne Hayson <whayson@pd-grp.com>
Cc: robert mccracken <Robert\_Mccracken@beaverton.k12.or.us>
Subject: RE: Beaverton SPL Update

Hi Wayne –

I've asked Robert to take a look. I believe you are correct and if Robert agrees, we can send you an email or correspondence saying so. Just let us know which would be better for your application.

SAS

From: Wayne Hayson <<u>whayson@pd-grp.com</u>>
Sent: Wednesday, March 1, 2023 11:03 AM
To: Steven Sparks - Exec Admin <<u>Steven\_Sparks@beaverton.k12.or.us</u>>
Subject: Beaverton SPL Update

## A This is from a Non-BSD Email address: Please only click links and attachments if you are sure they are safe

Hi Steve,

I hope you are doing well. Busy times for the school district with the weather. I am glad all the middle school redistricting is over, that was quite a process.

In any event, we are submitting a design review application to the City of Beaverton for 37 attached units at the Vineyard at Cooper Mountain subdivision, and the City has asked us to address SPL requirements. I am trying to establish what information you will need, or if we can get confirmation that no additional BSD SPL will be required. You were the signatory on the original letter, so I thought I would send this straight to you.

The attached SPL was previously issued for Vineyard at Cooper Mountain, encompassing the entire 297-lot planned unit development. The current application is for Design Review for Phase 1C of the development, shown in the attached site plan. The application is to approve these attached units on the previously approved lots, subject to the City's building design standards. The 37 single family attached dwellings in this application are included in the 297 units approved, as were the streets, pathways, and landscaping. No additional units or increase in density is proposed, and there are no additional impacts to the school district anticipated from the original submittal.

Please let me know what information you require, if any, or if you have any questions.

Thanks for your help.

I hope you are keeping well!

#### Wayne Hayson | PLANNING MANAGER | D 971.708.6274

PIONEER DESIGN GROUP, INC. CIVIL ENGINEERING | LAND USE PLANNING | LAND SURVEYING | LANDSCAPE ARCHITECTURE OREGON: 9020 SW Washington Square Rd. Suite 170 Portland, OR 97223 P 503.643.8286 ext. 1019 HAWAII: PO Box 283304, Honolulu, HI 96828 P 808.753.2376 pd-grp.com

Disclaimer:

This e-mail may contain proprietary, confidential, and/or privileged information. If you are not the intended recipient (or have received this e-mail in error), please notify the sender immediately by email or telephone (503-643-8286) and delete this message along with any attachments without copying or disclosing the contents. Any unauthorized copying, disclosure or distribution of the material in this e-mail is strictly forbidden. Pioneer Design Group, Inc. (PDG) shall not be liable for any changes made to the electronic data transferred. Distribution of electronic data to others is prohibited without the express written consent of PDG.

Follow us!	
------------	--

The District prohibits discrimination and harassment based on any basis protected by law, including but not limited to, an individual's actual or perceived race, color, religion, sex, sexual orientation, gender identity, gender expression, national or ethnic origin, marital status, age, mental or physical disability, pregnancy, familial status, economic status, veteran status or because of a perceived or actual association with any other persons within these protected classes.

The contents of this email and any attachments are confidential. They are intended for the named recipient(s) only. If you've received this communication in error, please immediately notify us by phone at 503-356-4500 and destroy the original message. Thank you.